


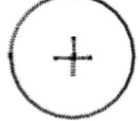








Continue erosion barrier along temporary access

Temporary Access Road

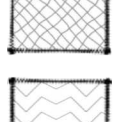
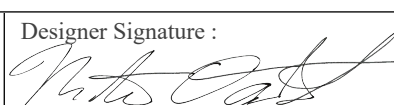
NAME	QTY.	SIZE	SPACING
 HOLODISCUS DISCOLOR OCEAN-SPRAY	5	2 Gal	60" o.c.
 SYMPHORICARPOS ALBUS COMMON WHITE SNOWBERRY	18	2 Gal	36" o.c.
 VACCINIUM OVATUM EVERGREEN HUCKLEBERRY	10	2 Gal	36" o.c.
 ARCTOSTAPHYLOS UVA-URSI KINNIKINNICK	342	4" Pot	12" o.c.
 GRASS SEED	601 SF	SEED WITH GRASS SEED MIX IN DISTURBED AREAS BY HAND	
 NEW ALLAN BLOCK WALL	SEE ENGINEERED PLANS		
 EXISTING SOLDER PILE WALL	SEE ENGINEERED PLANS		
 EXISTING GUNITE CONCRETE	AS IS		
 CRUSHED ROCK GRAVEL	431 SF		
 EROSION CONTROL BARRIER	AS SHOWN IN PLAN AND ALONG TEMP ACCESS ROAD SILT FENC AND WATTLE DETAIL PAGE 2		

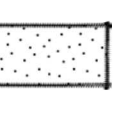30" Tree


28" Tree

NORTH


Continue erosion barrier up to house footing if possible

 WESTERN LANDSCAPE & PAVERS^{LLC} 425.979.1933		
Oquist <i>Soli Deo Gloria</i> Landscape Design www.OquistLandscapeDesign.com 425.219.1510 OquistLandscapeDesign@gmail.com	Scale: 1/8" = 1' Date: 7/22/2019 Site Address: 8100 SE 48th St Mercer Island, WA 98040 Drawing Description: Planting & Erosion Control Plan View	Property Owner: Ron Beresky Contact #: 608.609.4180 Designer Signature:  Drawing Number: 1 of 2

FENCE POSTS DRIVEN INTO GROUND 12" MIN

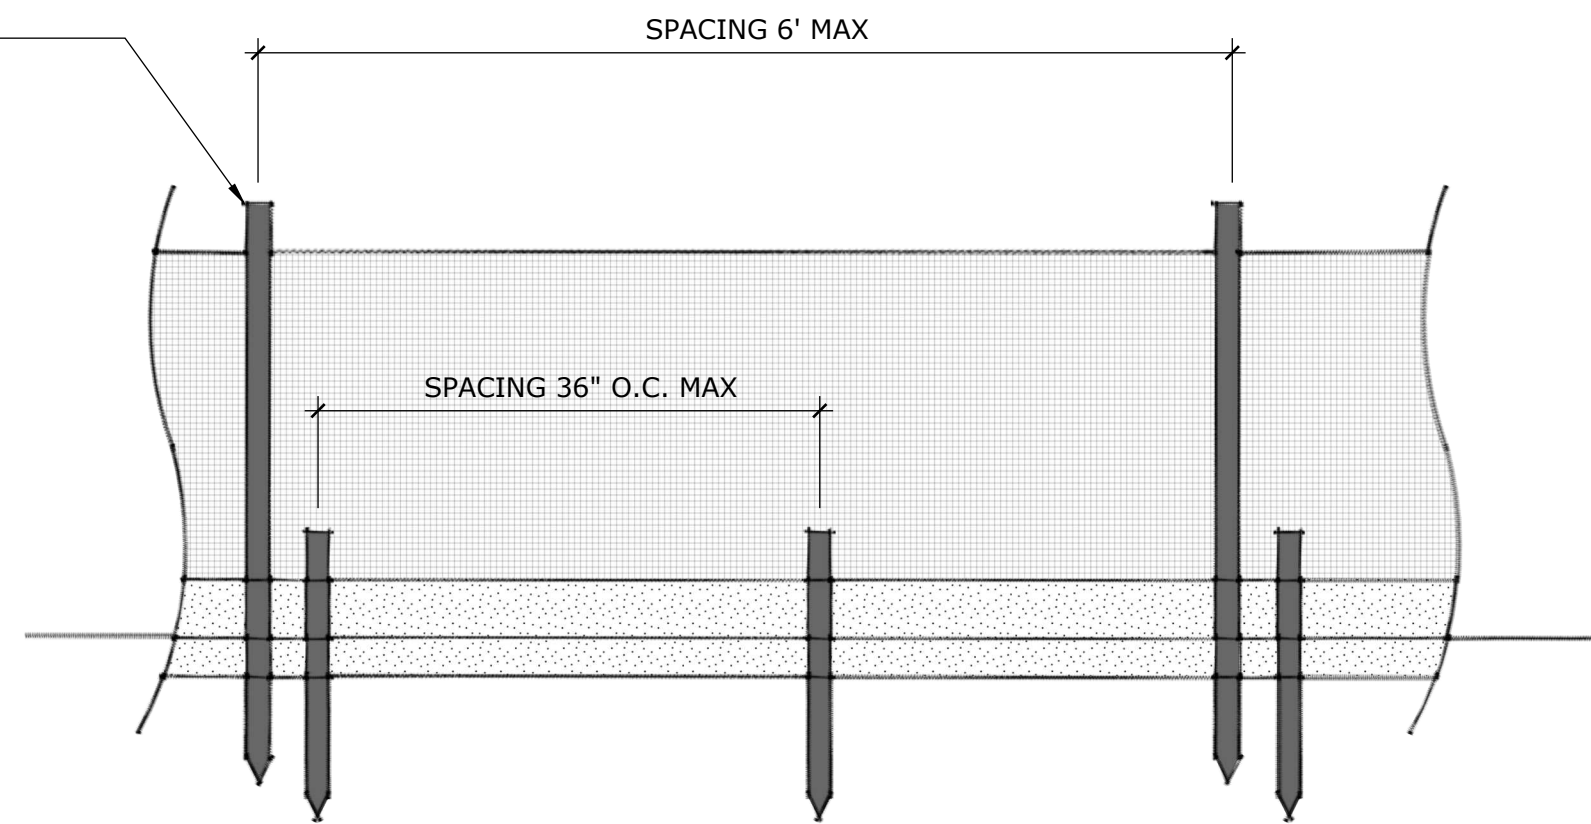

UNDISTURBED VEGETATION

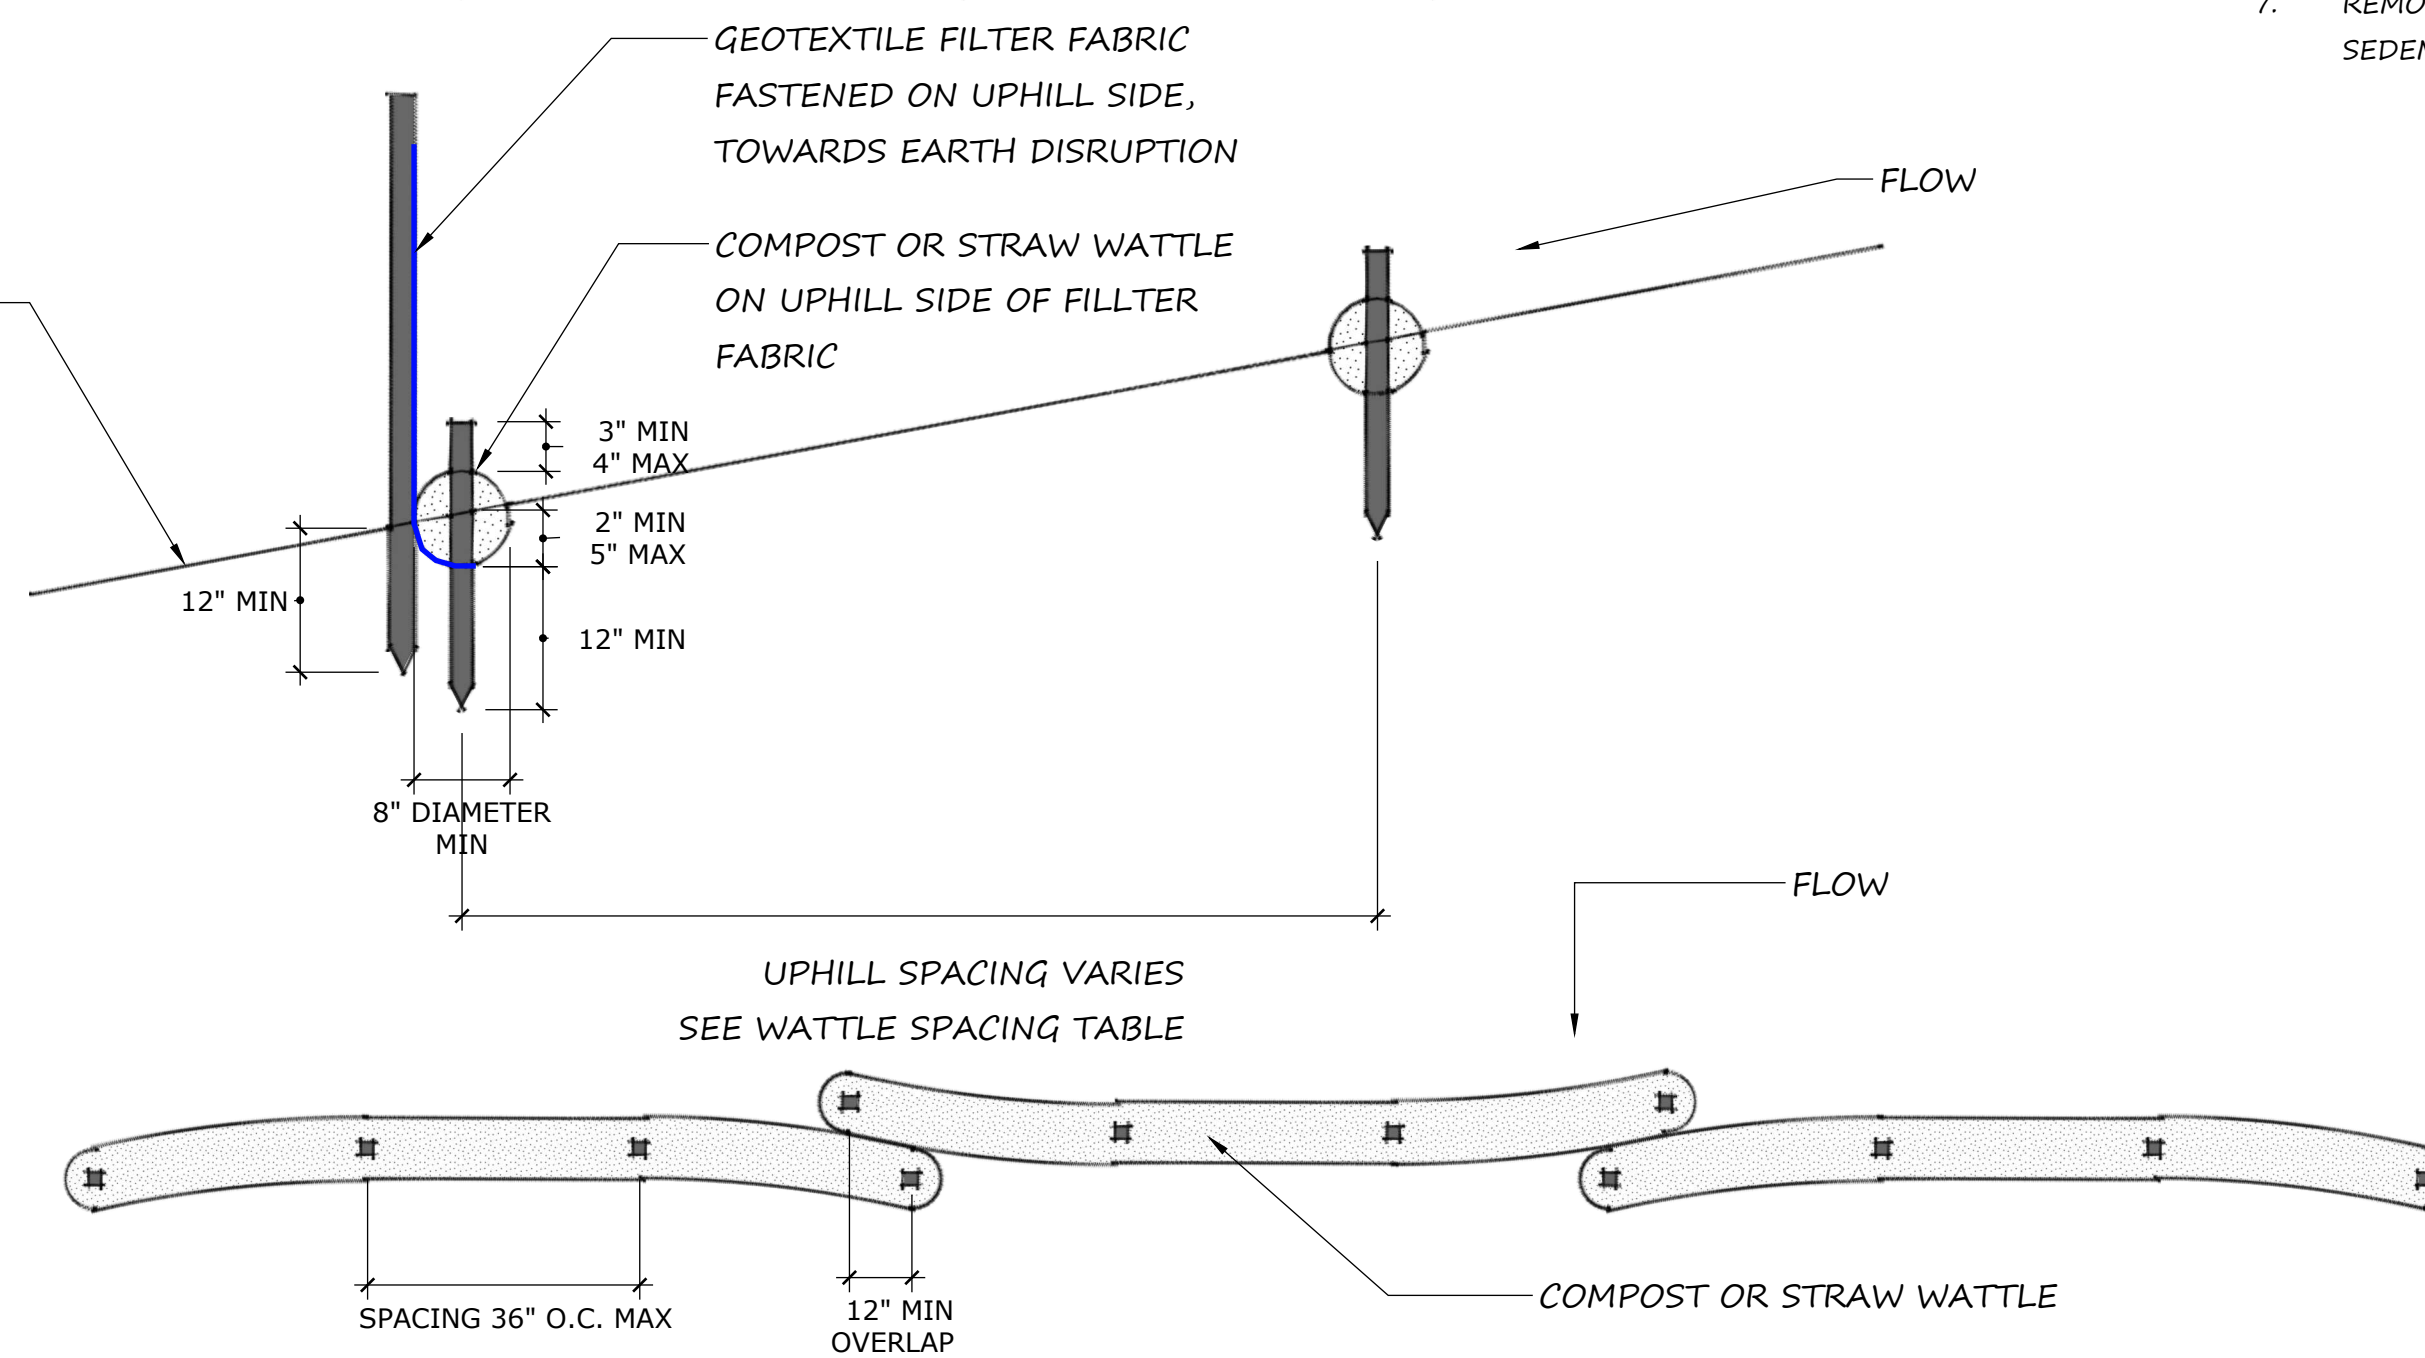

NOTES:

1. GEOTEXTILE FILTER FABRIC FENCE SHOWN IN BLUE ON DIAGRAM
2. COMPOST WATTLES RECOMMENDED ON SLOPES. USE STRAW WATTLES IN PAVEMENT APPLICATION.
3. ON SLOPES, INSTALL WATTLES PERPENDICULAR TO THE FLOW DIRECTION ANDS PARRALLEL TO THE SLOWPE SONTOURS. INSTALLATION SHALL BE IN ACCORDANCE WITH WSDOT STANDARDS SPECIFICATION 8-01.3(10).
4. RUNOFF SHALL NOT RUN UNDER OR AROUND ROLL. ADDITIONAL STAKING MAY BE NECESSARY TO PREVENT UNDERCUTTING.
5. WATTLES SHALL BE INSPECTED REGULARLY, AND IMMEDIATELY AFTER A RAINFALL PRODUCES RUNOFF. REMOVE SEDIMENT AND ACCUMULATIONS WHEN EXCEEDING 1/2 HEIGHT BETWEEN THE TOP OF THE WATTLE AND THE GROUND SURFACE.
6. FABRIC TEARS, POST FAILURES, VEHICLE DAMAGE, AND/OR UNDERMAINING SHOULD BE REPAIRED IMMEDIATELY.
7. REMOVE SILT FENCE AND WATTLE AFTER THE SITE HAS BEEN STABILIZED WITH PERMANENT SOIL EROSION / SEDEMENTATION CONTROL MEASURES.

8" DIAMETER WATTLE SPACING TABLE	
SLOPE	MAXIMUM SPACING
1H:1V	10'-0"
2H:1V	20'-0"
3H:1V	30'-0"
4H:1V	40'-0"
>4H:1V	ONE RUN ONLY

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Oquist <i>Soli Deo Gloria</i> Landscape Design		Scale: 1/8" = 1' Date: 7/22/2019	Property Owner: Ron Beresky Contact #: 608.609.4180
www.OquistLandscapeDesign.com 425.219.1510 OquistLandscapeDesign@gmail.com		Site Address: 8100 SE 48th St Mercer Island, WA 98040	Designer Signature:
Drawing Description: Erosion Control Detial			Drawing Number: 2 of 2